寄件者∶ 寄件日期∶	2025年07月16日星期三 19:37
收件者: 副本:	tpbpd/PLAND
主旨: 附件:	Supplementary Information S16 Planning Application No. A/YL-KTN/1142 AYL-KTN 1142 20250716.pdf

Thank you for the phone call. Please see the attachment for the draft further infomation. Please contact Mr. Tang via email if you have any question regarding to the captioned application.

Yours sincerely, Mr. Tang

<u>A/YL-KTN/1142 申請詳細</u>

在申請範圍的邊界計劃以金屬實心的物料,例如鋅鐵將申請範圍圍起,圍邊高度約 2.5 米高。

由於現時申請範圍內的建築物超出 A/YL-KTN/1017 所批准的上蓋面積, 並計劃將貨倉與辦公室分開運作,因此希望透過新的規劃申請規範化,及向地 政總署繼續申請短期租約及短期豁免書。

預計本申請地點的車流為以下:

	★ 軒 軸 □ (1)	ま 転 戦 口 (川)
時段	車輛數目(入)	車輛數目(出)
00:00-01:00	0	0
01:00-02:00	0	0
02:00-03:00	0	0
03:00-04:00	0	0
04:00-05:00	0	0
05:00-06:00	0	0
06:00-07:00	0	0
07:00-08:00	0	0
08:00-09:00	0 - 2	0-2
09:00-10:00	0 - 2	0-2
10:00-11:00	0 - 2	0-2
11:00-12:00	0 - 2	0-2
12:00-13:00	0 - 2	0-2
13:00-14:00	0 - 2	0-2
14:00-15:00	0 - 2	0 - 2
15:00-16:00	0 - 2	0-2
16:00-17:00	0 - 2	0-2
17:00-18:00	0 - 2	0-2
18:00-19:00	0 - 2	0-2
19:00-20:00	0 - 2	0-2
20:00-21:00	0	0
21:00-22:00	0	0
22:00-23:00	0	0
23:00-00:00	0	0


為了方便上落貨物和方便員工駕車到本申請地點,現申請2個客貨車上 落貨位置及2個私家車停車位。本申請地點不會對公眾開放,因此上述的客貨 車上落貨位置及私家車停車位已足夠此申請運作。

S.16 Planning Application No. A/YL-KTN/1142


申請地點有道路連接,前往本申請地點途經水尾路,再轉到郊區小徑到 達申請地點。水尾路沿途道路為單線雙程,約有 3-5 米闊,並設有避車處。私 家車及客貨車有足夠的位置通過及進行調遣的動作。申請地點的出入口約 6 米 闊。


在申請地點內有一個直徑超過 7 米及一個直徑超過 8 米的圓形空間,足 夠讓車輛進行調遣的動作,進入本申請地點的車輛不會在公用道路上讓車輛等 候進入本申請地點,停泊在公用道路及以倒後形式進出本申請地點。參考文件 末端的 Appendix 2。

希望此附加文件能釋除 貴委員會的查詢,並支持本申請。

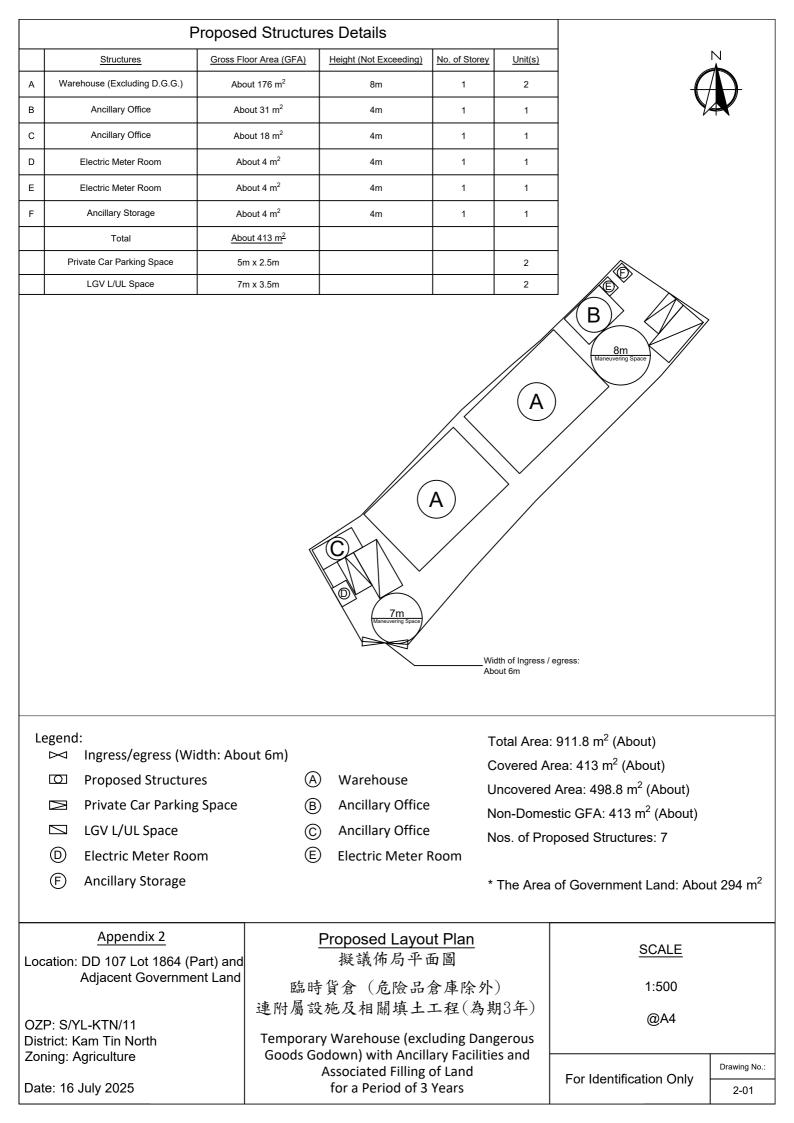



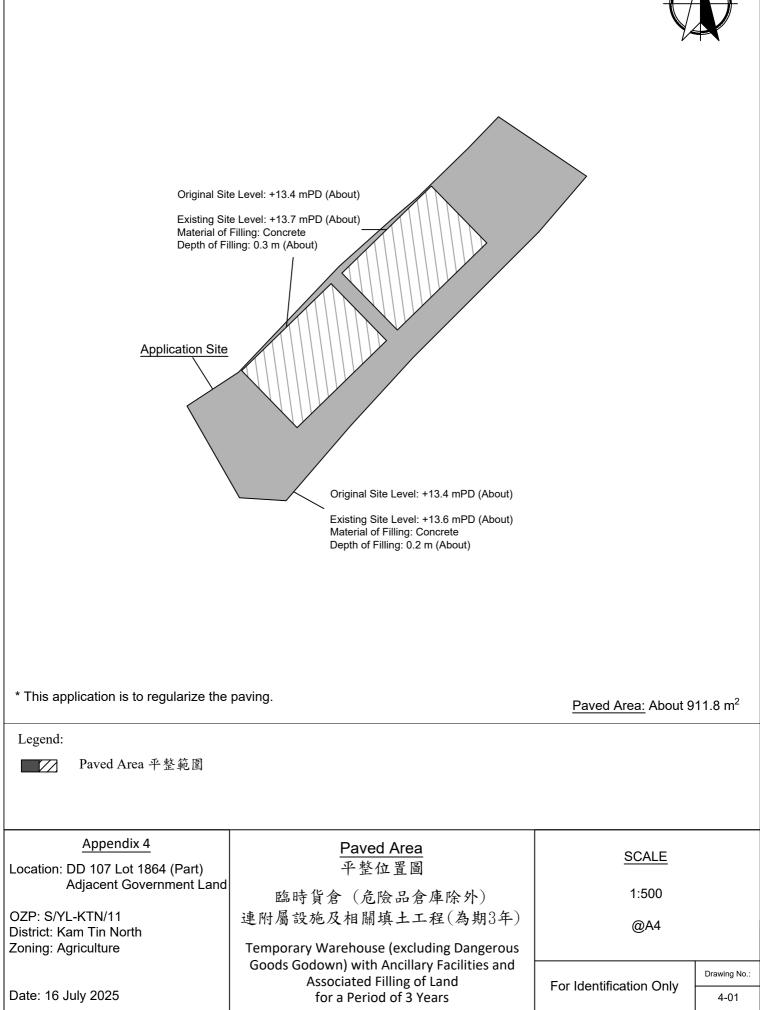

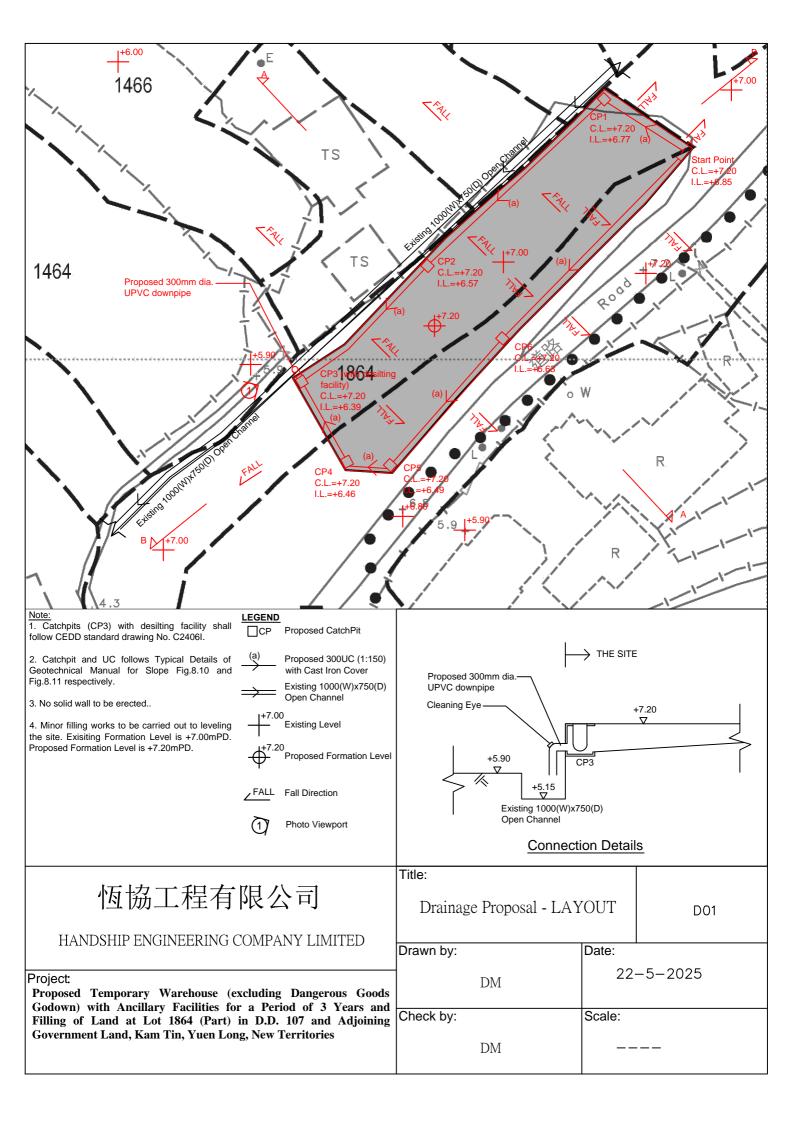

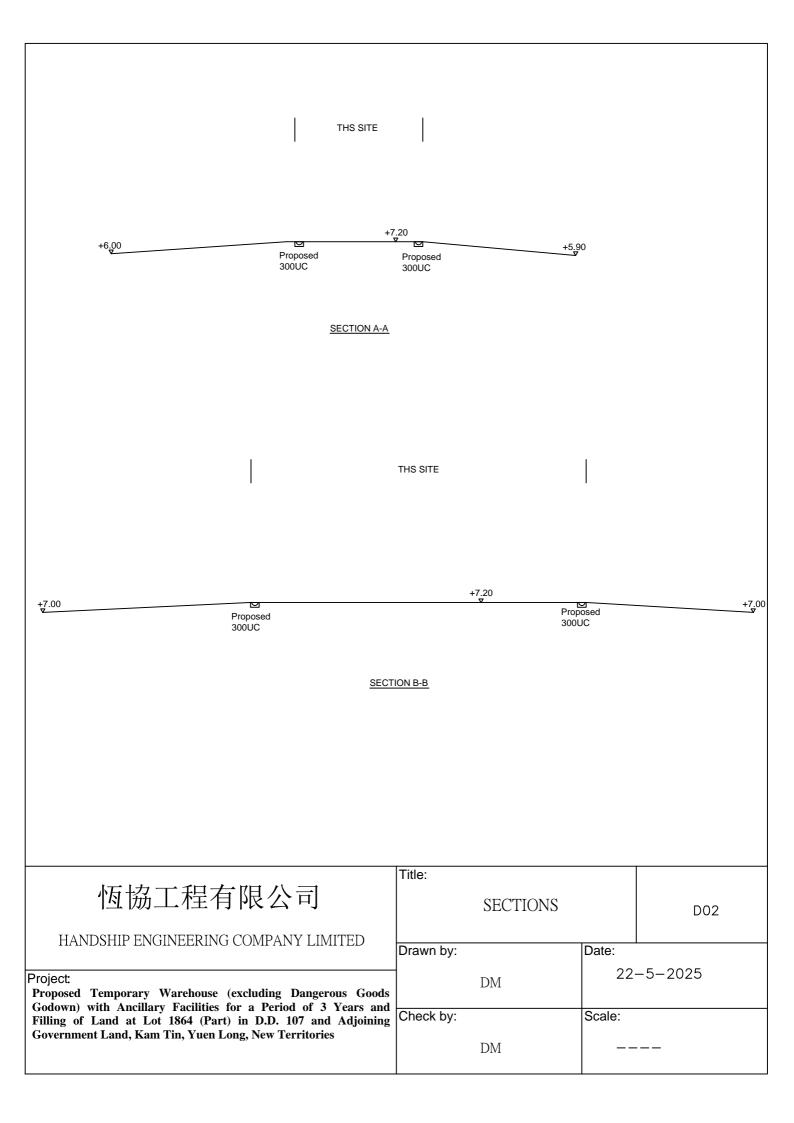


Photo 1






前往地圖: https://www.map.gov.hk/gm/geo:22.4501,114.0608?z=2257



Further downstream of proposed discharge point

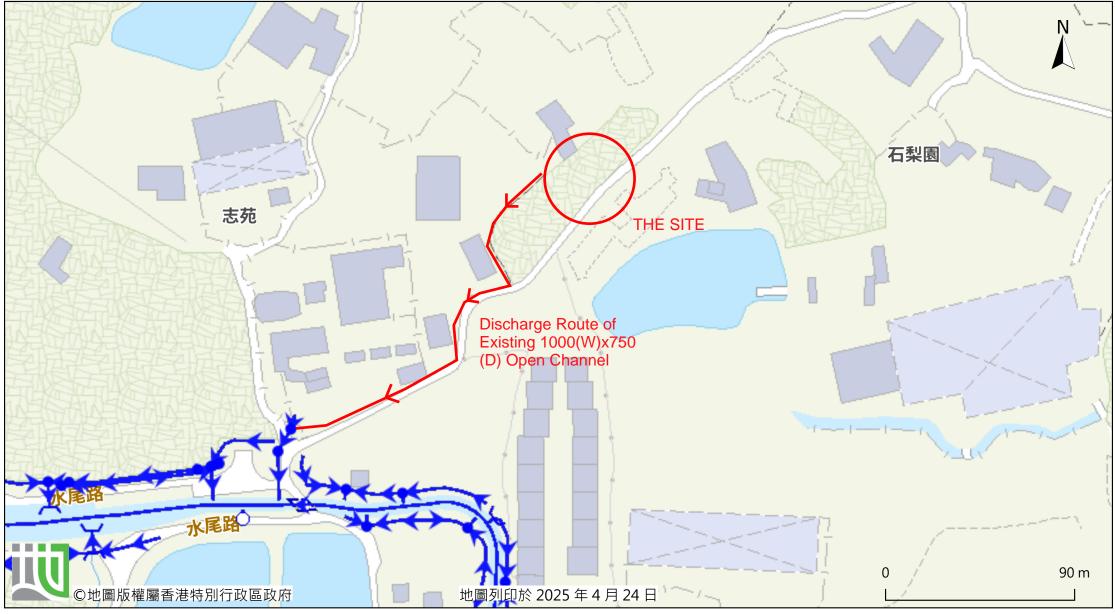


由「地理資訊地圖」網站提供: https://www.map.gov.hk 注意: 使用此地圖受「地理資訊地圖」的使用條款及條件以及知識產權告示約束。

THE SITE, Area		= 912	m^2	(C=	0.95)	
Calculation of Design Runoff of the Proposed Development, For the design of drains inside the site							
_		$= \Sigma 0.278 \mathrm{C}\mathrm{i}\mathrm{A}$					
	А	= 912	m^2				
		= 0.000912	km ²				
	t	$= 0.14465 \text{ L/ H}^{0.2} \text{A}^{0.1}$					
		$= 0.14465*7.5/1^{0.2}*912^{0}$.1				
		= 2.185	min				
	i	$= 1.111*a/(t+b)^{c}$		(50 yrs retur	n period	l, Table 3a, Corrigendum 2024,	
		= 1.111*505.5/(2.185+3	.29) ^{0.355}	SDM) and (l 1.1% ii	ncrease due to climate change)	
		= 307.1	mm/hr				
Therefore,	Q =	= 0.278*0.95*307.1*0.0	0.278*0.95*307.1*0.000912				
		= 0.0740	m ³ /sec				
		= <u>4438</u>	lit/min				
Provide 300UC (1:150) is OK							


Geotechnical Engineering Office, Civil Engineering and Development Department The Government of the Hong Kong Special Administrative Region


GEO Technical Guidance Note No. 43 (TGN 43) Guidelines on Hydraulic Design of U-shaped and Half-round Channels on Slopes

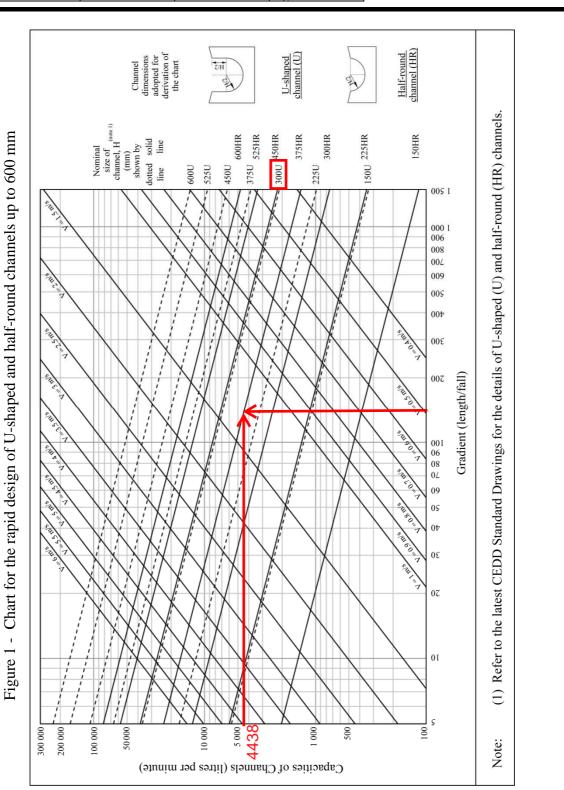

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ANNEX TGN 43 A1



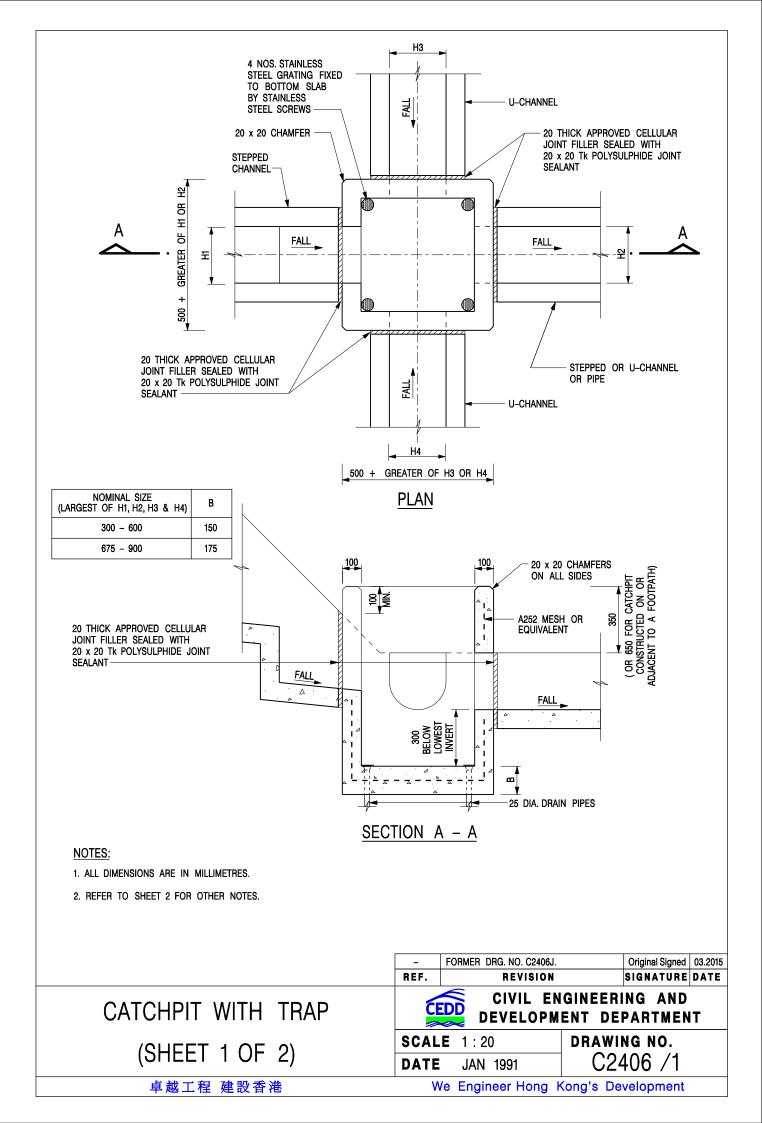

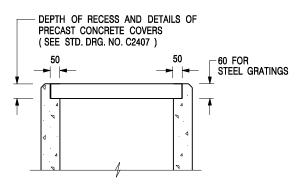ALTERNATIVE TOP SECTION FOR PRECAST CONCRETE COVERS / GRATINGS

NOTES:

- 1. ALL DIMENSIONS ARE IN MILLIMETRES.
- 2. ALL CONCRETE SHALL BE GRADE 20 /20.
- 3. CONCRETE SURFACE FINISH SHALL BE CLASS U2 OR F2 AS APPROPRIATE.
- 4. FOR DETAILS OF JOINT, REFER TO STD. DRG. NO. C2413.
- 5. CONCRETE TO BE COLOURED AS SPECIFIED.
- UNLESS REQUESTED BY THE MAINTENANCE PARTY AND AS DIRECTED BY THE ENGINEER, CATCHPIT WITH TRAP IS NORMALLY NOT PREFERRED DUE TO PONDING PROBLEM.
- 7. UPON THE REQUEST FROM MAINTENANCE PARTY, DRAIN PIPES AT CATCHPIT BASE CAN BE USED BUT THIS IS FOR CATCHPITS LOCATED AT SLOPE TOE ONLY AND AS DIRECTED BY THE ENGINEER.
- 8. FOR CATCHPITS CONSTRUCTED ON OR ADJACENT TO A FOOTPATH, STEEL GRATINGS (SEE DETAIL 'A' ON STD. DRG. NO. C2405) OR CONCRETE COVERS (SEE STD. DRG. NO. C2407) SHALL BE PROVIDED AS DIRECTED BY THE ENGINEER.
- 9. IF INSTRUCTED BY THE ENGINEER, HANDRAILING (SEE DETAIL 'G' ON STD. DRG. NO. C2405; EXCEPT ON THE UPSLOPE SIDE) IN LIEU OF STEEL GRATINGS OR CONCRETE COVERS CAN BE ACCEPTED AS AN ALTERNATIVE SAFETY MEASURE FOR CATCHPITS NOT ON A FOOTPATH NOR ADJACENT TO IT. TOP OF THE HANDRAILING SHALL BE 1 000 mm MIN. MEASURED FROM THE ADJACENT GROUND LEVEL.
- 10. MINIMUM INTERNAL CATCHPIT WIDTH SHALL BE 1 000 mm FOR CATCHPITS WITH A HEIGHT EXCEEDING 1 000 mm MEASURED FROM THE INVERT LEVEL TO THE ADJACENT GROUND LEVEL. AND, STEP IRONS (SEE DSD STD. DRG. NO. DS1043) AT 300 ¢ STAGGERED SHALL BE PROVIDED. THICKNESS OF CATCHPIT WALL FOR INSTALLATION OF STEP IRONS SHALL BE INCREASED TO 150 mm.
- 11. FOR RETROFITTING AN EXISTING CATCHPIT WITH STEEL GRATING, SEE DETAIL 'F' ON STD. DRG. NO. C2405.
- 12. SUBJECT TO THE APPROVAL OF THE ENGINEER, OTHER MATERIALS CAN ALSO BE USED AS COVERS / GRATINGS.

	– FORMER DRG.	NO. C2406J. Original Signed 03.2015			
	REF. R	EVISION SIGNATURE DATE			
CATCHPIT WITH TRAP	CI CEDD DEV	CIVIL ENGINEERING AND DEVELOPMENT DEPARTMENT			
(SHEET 2 OF 2)	SCALE 1:20	DRAWING NO.			
(0=)	DATE JAN 199	en C2406 /2			
卓越工程 建設香港	We Engineer	r Hong Kong's Development			

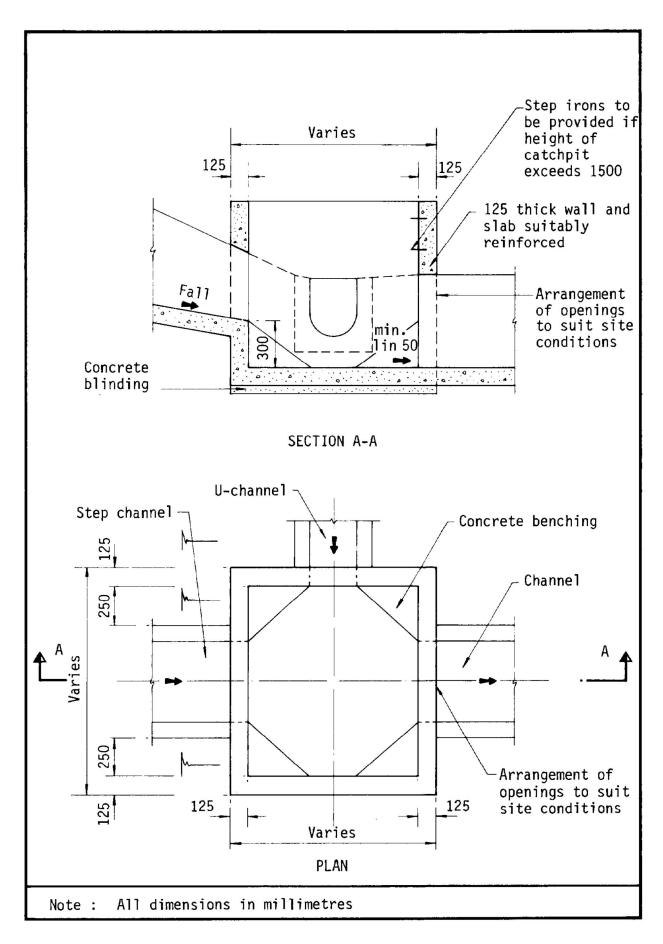


Figure 8.10 - Typical Details of Catchpits

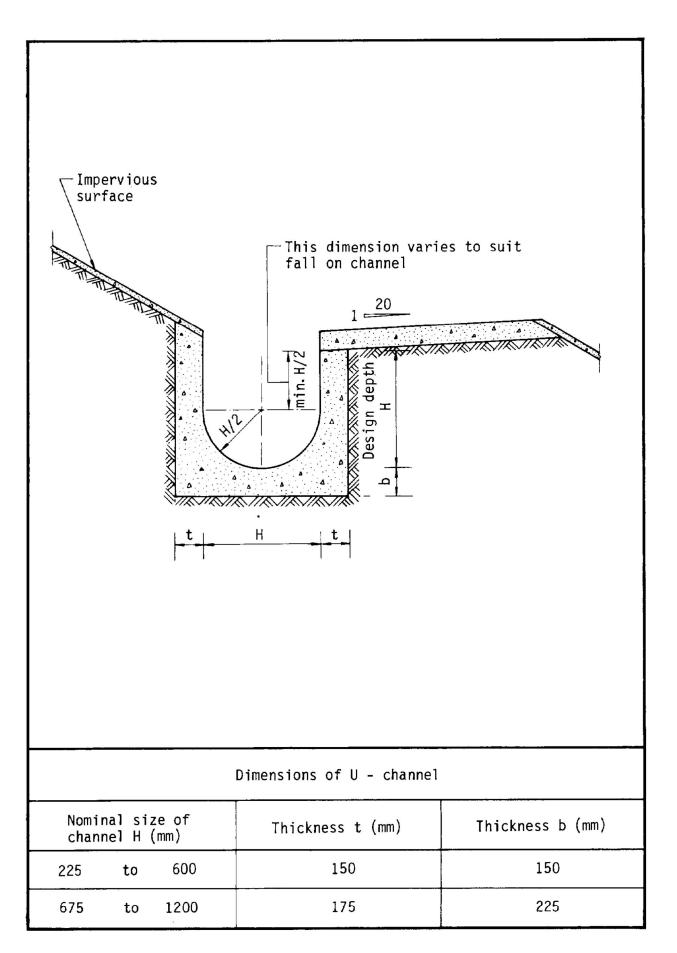


Figure 8.11 - Typical U-channel Details

	P	roposed Structur	es Details				Ņ	
	Structures	Gross Floor Area (GFA)	Height (Not Exceeding)	No. of Storey	Unit(s)	-		
А	Warehouse (Excluding D.G.G.)	About 176 m ²	8m	1	2	-		
в	Ancillary Office	About 31 m ²	4m	1	1	-		
С	Ancillary Office	About 18 m ²	4m	1	1	-		
D	Electric Meter Room	About 4 m ²	4m	1	1	-		
Е	Electric Meter Room	About 4 m ²	4m	1	1	-		
F	Ancillary Toilet	About 4 m ²	4m	1	1	-		
	Total	About 413 m ²				-		
	Private Car Parking Space	5m x 2.5m			2	-		
	LGV L/UL Space	7m x 3.5m			2			
 *All FSI (includes installation/maintenance/modification/repair work) will be completed by RFSIC. *Ar For Emergency Vehicular Access, Please see Appendix 6.1 *All the enclosed structures are provided with access for emergency vehicles to reach within 30m travel distance from the structures. Legend: S kg Portable Dry Powder Type Fire Extinguisher (7 in Total) Emergency Lighting (BS 5266-1:2016, BS EN 1838:2013 and the FSD Circular Letter No. 4/2021) (7 in Total) Emergency Vehicular Access Private Car Parking Space LGV L/UL Space 								
Loca	<u>Appendix 6</u> ation: DD 107 Lot 1864 (Pa Adjacent Governmen	d Fire Service Ir 議消防設備安 時貨倉(危險	支計劃圖 品倉庫除	外)	<u>SCALE</u> 1:500			
OZP: S/YL-KTN/11連附屬設施及相關填土工程(為期3年)District: Kam Tin North Zoning: AgricultureProposed Temporary Warehouse (excluding Dangerous Goods Godown) with Ancillary					@A4	Drawing No.:		
Date	e: 8 May 2025	Faciliti	cilities and Associated Filling of Land for a Period of 3 Years			For Identification Only	6-01	

